

Building Elements	Material	Detail
External walls - Including	Brick Veneer	R2.5 insulation – Product R-Value
Foyer/lobby		
Walls Within Units	Plasterboard on studs	
Walls between Units	Hebel + Stud + Insulation + Gyprock	in the second se
Walls between Units &	Hebel + Stud + Insulation + Gyprock	-
Lobby		
Walls between units &	200mm Concrete + Stud + Insulation +	•
Firestairs/LiftShaft	Gyprock	
Floors	Concrete	R2.0 insulation - Product R-Value to units:
		<ul> <li>G.01 / G.02 / 1.04 – suspended floor above basement &amp;</li> </ul>
		Basement ramp
Ceilings	Plasterboard	8
Roof - G.01 / 1.02	Concrete – Insulation to concrete	R2.0 insulation – Product R-Value
	exposed to external environment	
Top Floor Roof	Concrete	R3.0 insulation – Product R-Value
Doors / Windows - Single	Glazed Clear to all Units (& Foyer/lobbys)	except as stated below:
Awning windows	U value 6.70 or less and SHGC 0.57 +/- 10	%
Sliding Doors / Fixed	U value 6.70 or less and SHGC 0.70 +/- 10	-4
Shulling Doors / Tixeu	O value 6.70 or less and smoc 0.70 1/- 10	%
Glazing  Doors / Windows - Double	e Glazed High Solar Gain — Low E to Sliding	%  Doors / Fixed Windows & High Solar Gain Low E or Similar to
Glazing Doors / Windows - Double awning windows - to the Units G.01/1.02/1.03/1.04 Awning windows	e Glazed High Solar Gain – Low E to Sliding following units <u>(EXCLUDES ENS):</u> /2.02/2.03/2.04/3.02/3.03/3.04/4.02/4.03 U value 5.40 or less and SIIGC 0.49 +/- 10	Doors / Fixed Windows & High Solar Gain Low E or Similar to 74.04
Glazing  Doors / Windows – Doubla awning windows – to the Units G.01/1.02/1.03/1.04,  Awning windows  Sliding Doors / Fixed	e Glazed High Solar Gain — Low E to Sliding following units <u>(EXCLUDES ENS)</u> : /2.02/2.03/2.04/3.02/3.03/3.04/4.02/4.03/	Doors / Fixed Windows & High Solar Gain Low E or Similar to 74.04 76
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Glazing  Doors / Windows – Double awning windows – to the Units C.01/1.02/1.03/1.04  Awning windows – Street Glazing  Ceiling Fans: 900mm Diam Units 1.04 / 2.01 / 2.02 / 2.  Lighting: Units have been Note: Self-closing damper Insulation should be instal Additional insulation may This Development must co Building & Energy Consult	e Glazed High Solar Gain – Low E to Sliding following units [EXCLUDES ENS]: (2.02/2.03/2.04/3.02/3.03/3.04/4.02/4.03/ U value 5.40 or less and SHGC 0.49 +/- 10 U value 4.30 or less and SHGC 0.53 +/- 10 utility of the second se	Doors / Fixed Windows & High Solar Gain Low E or Similar to  4.04  6  6  as per NatHERS Certificate.  n & associated interaction with adjoining building materials



SCHEDULE OF COLOURS & FINISHES:

R1

01 EAST ELEVATION - DRUMMOND STREET
Scale 1: 200 @ A3

Scale: 1:100 @A1 1:200 @A3			Client:	Architect:	Project Details:	Drawing Title:	Project Number:	Drawing Number:
0 1 2 3 4 5			-	LOUCAS ARCHITECTS ABN 92 626 290 122	RESIDENTIAL DEVELOPMENT	ELEVATIONS 01	Pn-21010	A-2000
				Level 3, Suite 309, 7-9 Gibbons St.	Project Address:		Drawing Status:	Issue:
				Level 3, Suite 309, 7-9 Gibbons St, Redfern NSW, Australia	51 DRUMMOND STREET, BELMORE		AUTHORITY APPROVAL	R
			Level 3, Suite 309, 7-9 Gibbons St, Redfern NSW. Australia	Tel: (02) 8052 9600 Email: admin@loucasarc.com.au			7.011101(1117(111(047))	
Date Printed:	B ISSUE TO COUNCIL (DA SUBMISSION)	LE	28.01.2022 Tel: (02) 8052 9600		A S			
	·			Nominated Architect:  Jim Apostolou 7490  ARCHITE	C.T.S.		PLOT GENERATED BY LOUCAS ARCHITECTS   THIS DRAWING IS AN UNCONTRO THIS DRAWING SHOULD BE READ IN CONJUNCTION WITH ALL RELEVANT CO	OLLED COLL CHILLOSS IN WHILE DOLL LIKE HOLD
15/02/2022	A ISSUE TO CLIENT	IL	09.07.2021 Email: admin@loucasarc.com.au	A K O II I I E K			THIS DRAWING SHOULD BE READ IN CONJUNCTION WITH ALL RELEVANT CO DRAWINGS   COPYRIGHT OF THIS DRAWING IS VESTED IN LOUCAS ARCHITEC	rs
	ISSUE REVISION DESCRIPTION	APP'D	DATE					




## SOUTH ELEVATION - DRUMMOND LANE Scale 1:200@A3


Scale: 1:100 @A1 1:200 @A3			Client:	Architect:	Project Details:	Drawing Title:	Project Number:	Drawing Number:
ψ			-	LOUCAS ARCHITECTS ABN 92 626 290 122	RESIDENTIAL DEVELOPMENT	ELEVATIONS 02	Pn-21010	A-2100
				Level 3, Suite 309, 7-9 Gibbons St, Redfern NSW, Australia	Project Address: 51 DRUMMOND STREET, BELMORE		AUTHORITY APPROVAL	Issue:
			Level 3, Suite 309, 7-9 Gibbons St, Redfern NSW, Australia	Tel: (02) 8052 9600 Email: admin@loucasarc.com.au  Neminated Architects  LOUCA	· ·		AOTTORITTAFFROVAL	
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15/02/2022	A ISSUE TO CLIENT	TL 09.07.2021	Email: admin@loucasarc.com.au	Jim Apostolou 7490 ARCHITECT	S		THIS DRAWING SHOULD BE READ IN CONJUNCTION WITH ALL RELEVANT COI DRAWINGS   COPYRIGHT OF THIS DRAWING IS VESTED IN LOUCAS ARCHITECT	
15/02/2022	ISSUE REVISION DESCRIPTION	APP'D DATE						





Scale: 1:100 @A1 1:200 @A3			Client:	Architect:	Project Details:	Drawing Title:	Project Number:	Drawing Numbe
			_	LOUCAS ARCHITECTS	RESIDENTIAL DEVELOPMENT	ELEVATIONS 03	Pn-21010	A-22
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				Redfern NSW, Australia	51 DRUMMOND STREET, BELMORE		AUTHORITY APPROVAL	R
			Level 3, Suite 309, 7-9 Gibbons St, Redfern NSW, Australia	Tel: (02) 8052 9600			ACTIONITATINOVAL	D
Date Printed:				Email: admin@loucasarc.com.au  LOUCA	S			
Date Filliteu.	B ISSUE TO COUNCIL (DA SUBMISSION)	HE 28.01.2022		Nominated Architect:			PLOT GENERATED BY LOUCAS ARCHITECTS   THIS DRAWING IS AN UNCONTRO	
14/02/2022	A ISSUE TO CLIENT	TL 09.07.2021	Email: admin@loucasarc.com.au	Jim Apostolou 7490 ARCHITEC	1 5		THIS DRAWING SHOULD BE READ IN CONJUNCTION WITH ALL RELEVANT DRAWINGS   COPYRIGHT OF THIS DRAWING IS VESTED IN LOUCAS ARCHIT	_ONTRACTS, SPECIFICATION, REPORT LCTS
1-7/02/2022	ISSUE REVISION DESCRIPTION	APP'D DATE					'	

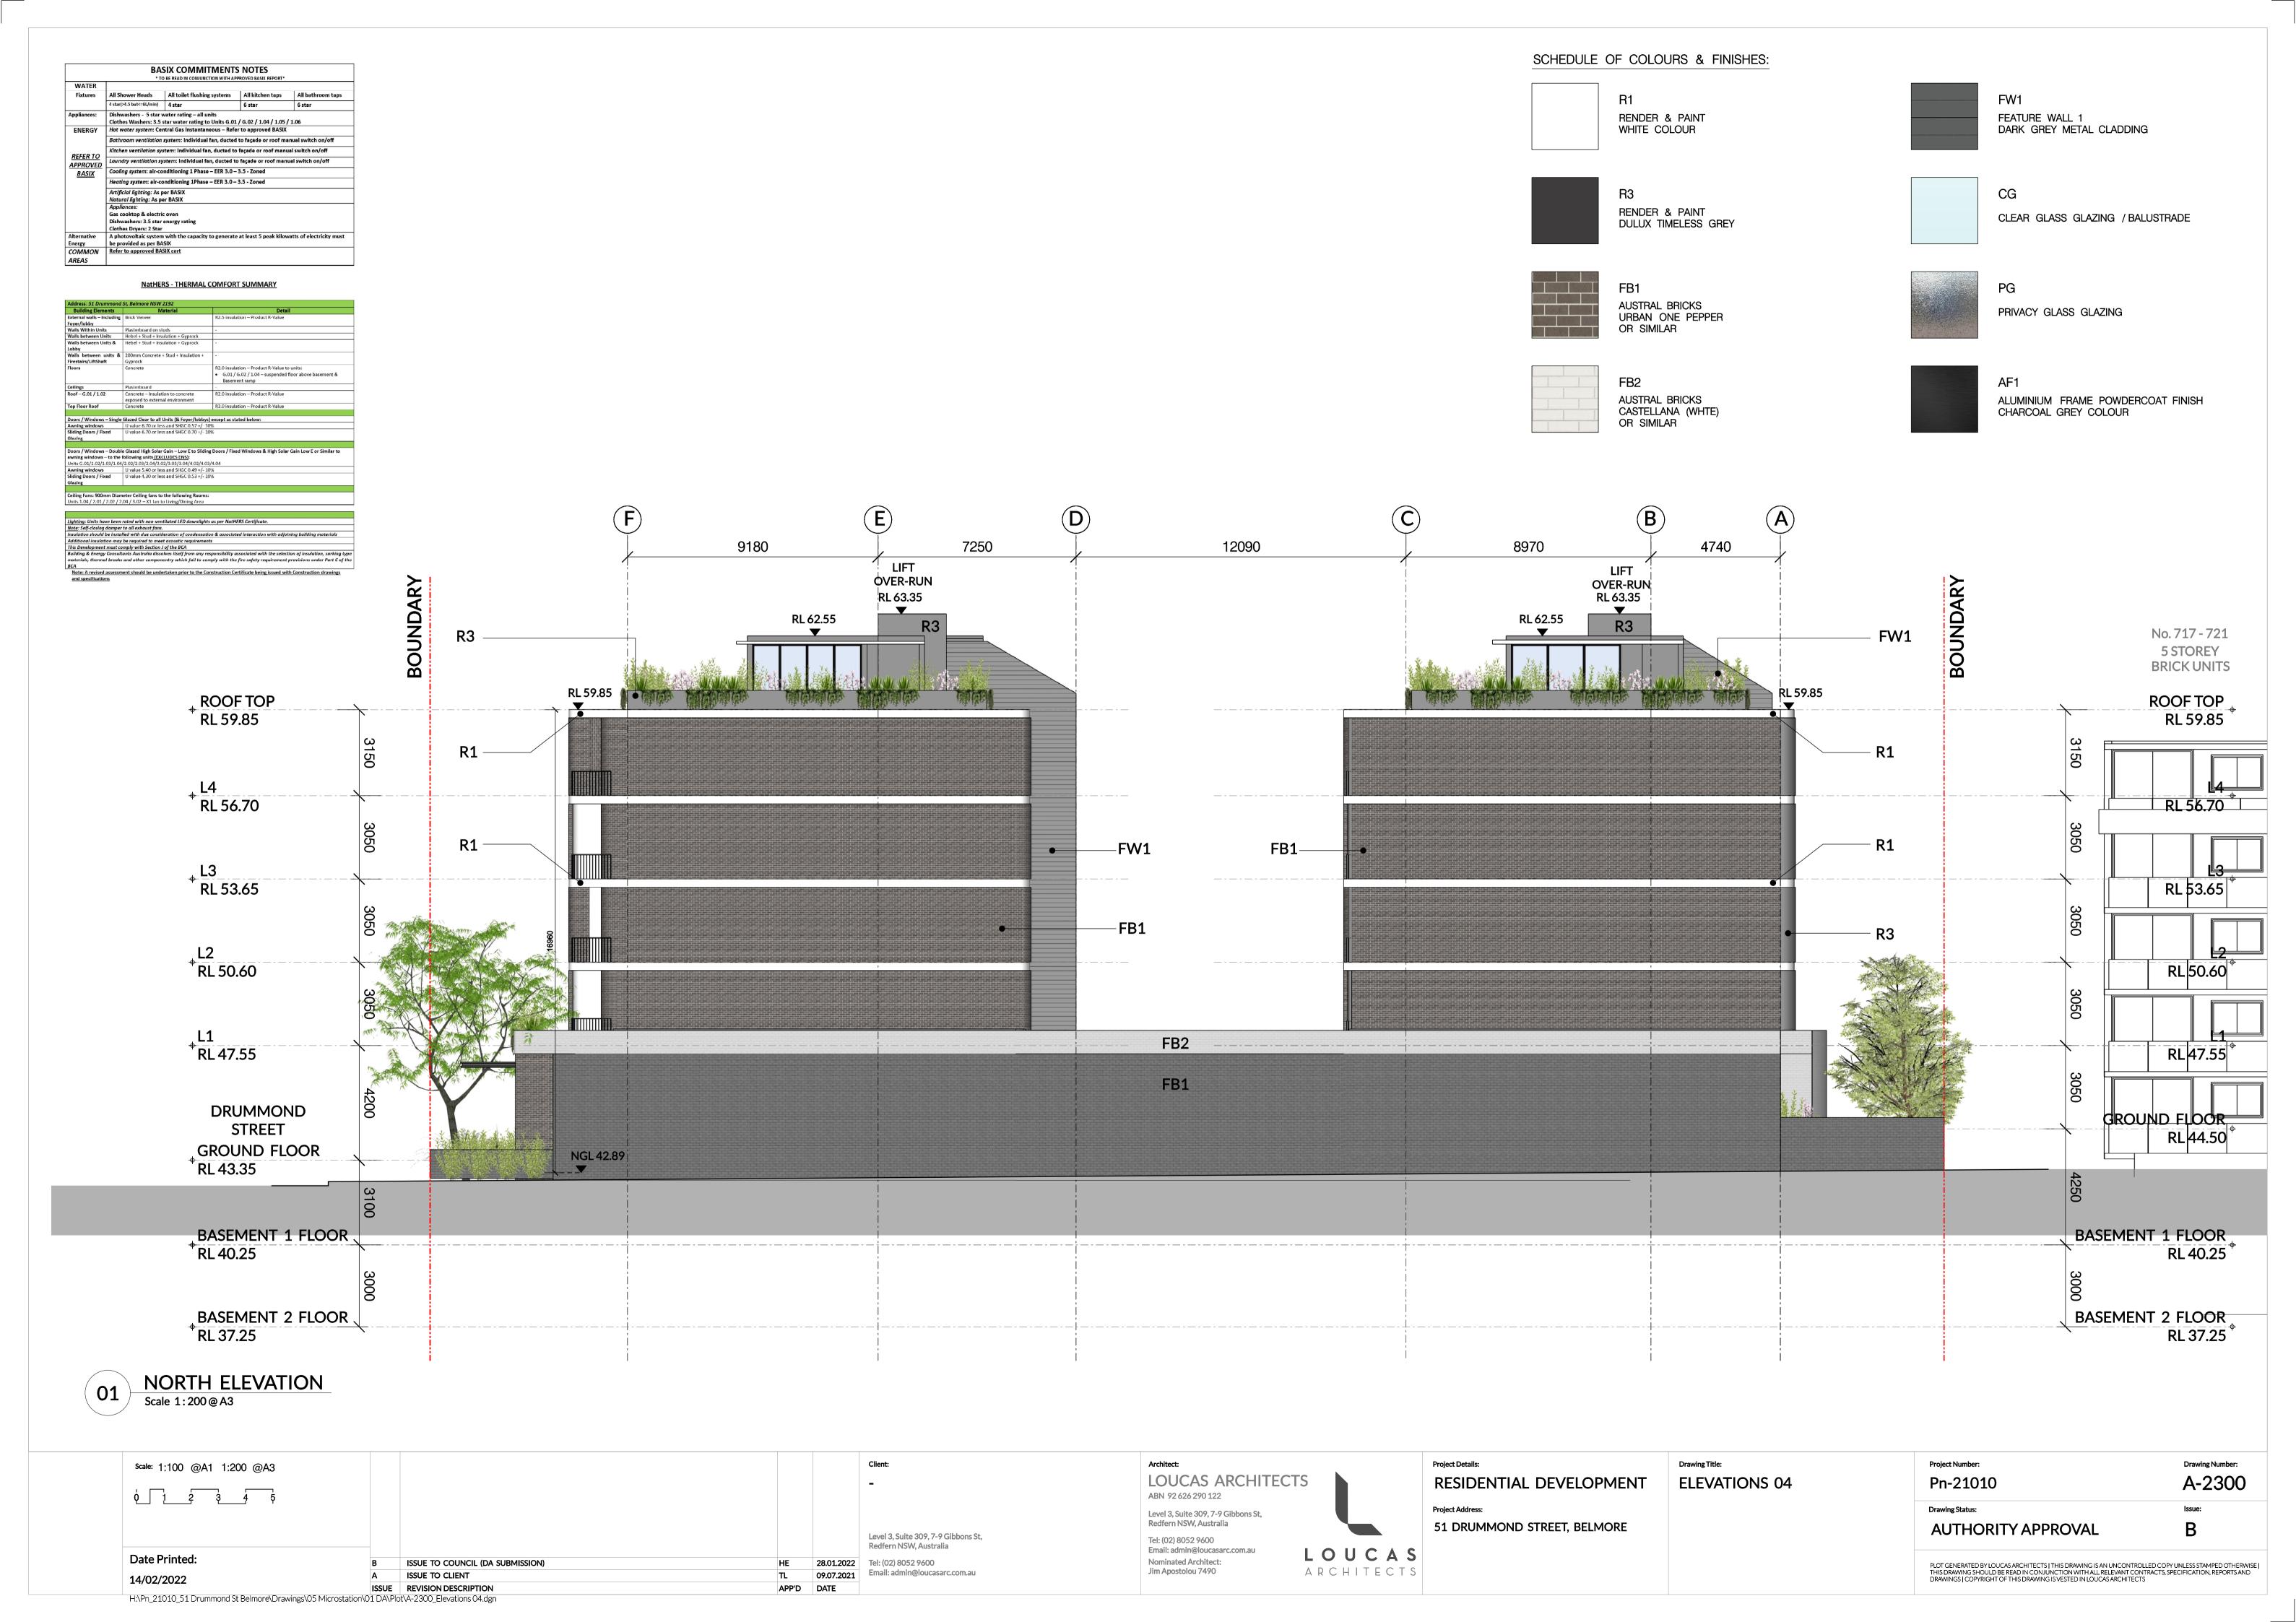

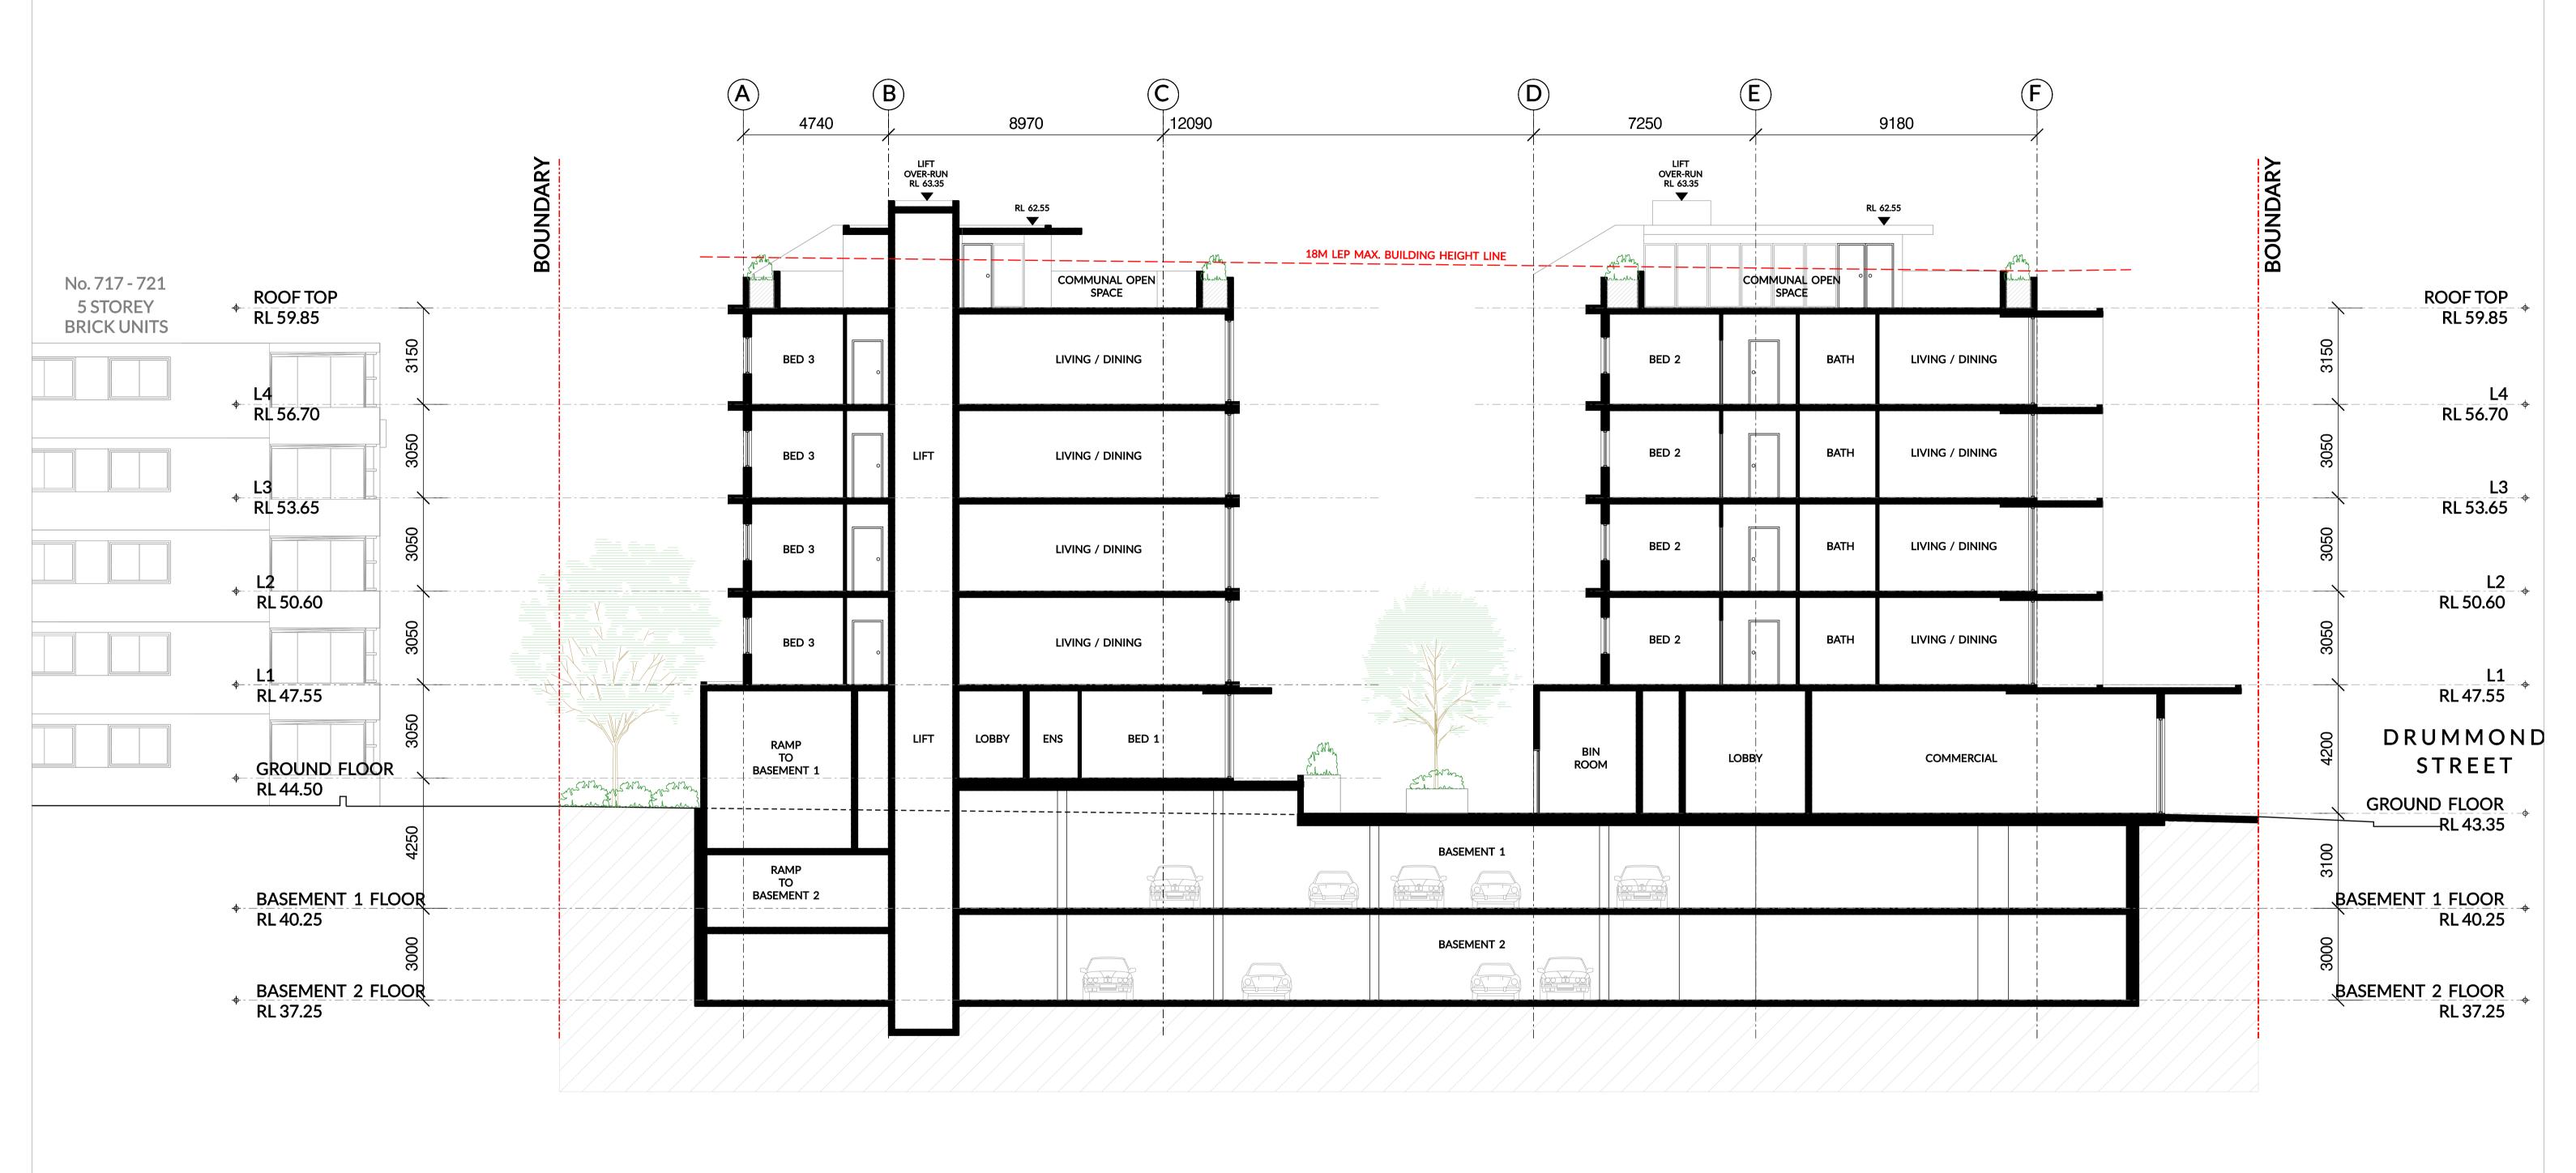

01 SECTION A - A
Scale 1:200@A3

Scale: 1:100 @A1 1:200 @A3			Client:	Architect:	Project Details:	Drawing Title:	Project Number:	Draw
0 1 2 3 4 5			-	LOUCAS ARCHITECTS ABN 92 626 290 122	RESIDENTIAL DEVELOPMENT	SECTION A - A	Pn-21010	A-
				Level 3, Suite 309, 7-9 Gibbons St, Redfern NSW, Australia	Project Address:		Drawing Status:	Issue
			Level 3, Suite 309, 7-9 Gibbons St,		51 DRUMMOND STREET, BELMORE		AUTHORITY APPROVAL	B
Data Drintada			Redfern NSW, Australia	Tel: (02) 8052 9600 Email: admin@loucasarc.com.au  Nominated Architect:  LOUCA	S			
Date Printed:	B ISSUE TO COUNCIL (DA SUBMISSION)	HE 28.01.2022		Nothinated Architect.			PLOT GENERATED BY LOUCAS ARCHITECTS   THIS DRAWING IS AN UNCONTROL	
14/02/2022	A ISSUE TO CLIENT	TL 09.07.2021	Email: admin@loucasarc.com.au	Jim Apostolou 7490 ARCHITECT	, S		THIS DRAWING SHOULD BE READ IN CONJUNCTION WITH ALL RELEVANT CON DRAWINGS   COPYRIGHT OF THIS DRAWING IS VESTED IN LOUCAS ARCHITECTS	
	ISSUE REVISION DESCRIPTION	APP'D DATE						•